



PROPOSED FRONT ELEVATION (north)
SCALE: 1:100



PROPOSED SIDE ELEVATION (west)
SCALE: 1:100




PROPOSED REAR ELEVATION (south)
SCALE: 1:100





PROPOSED SIDE ELEVATION (east)
SCALE: 1:100

FINISHES SCHEDULE	
	EXISTING HORIZONTAL CLADDING
	REPAINTED ANTHRACITE GREY
	EXISTING VERTICAL CORRUGATED SHEETING
	EXISTING CORRUGATED SHEETING
	ANTHRACITE GREY UPVC WINDOWS / DOORS

CEILING HEIGHTS	
	2m HIGH
	1.8m HIGH
	1.5m HIGH

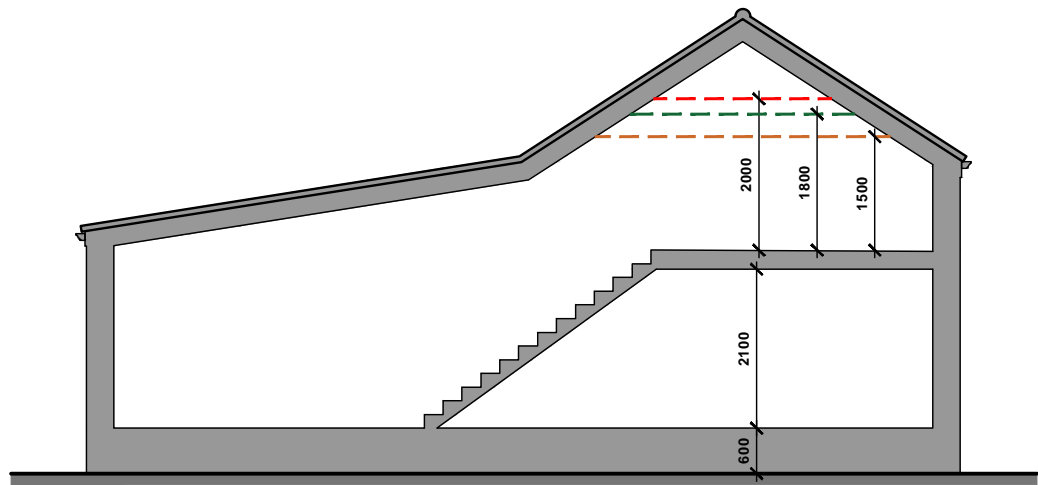

PROPOSED SECTION
SCALE: 1:100

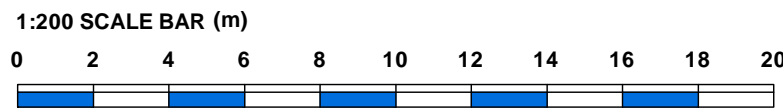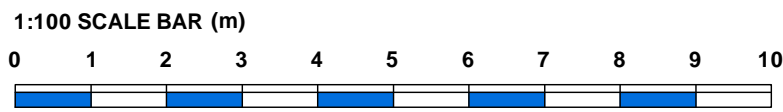

Notes:

This document is the property of David Trundley Design Services Ltd and may not be reissued, loaned or copied in part or in whole without written permission © 2022

All dimensions are in millimetres unless stated otherwise.

It is recommended that information is not scaled off this drawing.

This drawing should be read in conjunction with all other relevant information, specifications & schedules.

If this drawing is received electronically it is the recipients responsibility to print the document at the correct scale.

All dimensions to be checked on site prior to commencing work and any discrepancies to be advised immediately.

CONSTRUCTION (Design & Management) REGULATIONS 2015: David Trundley Design Services Ltd are employed as 'Designer' and will provide information to those responsible for the 'Principal Designer' and to the client.



David Trundley Design Services Ltd are responsible for the 'Architectural' design of the elements included on this drawing only.

Architectural design has been carried out with due consideration for the safety during construction, occupation and maintenance of the finished structure.

The works contain no extraordinary hazards or risks that are not present during routine construction operations that would not readily be apparent to a competent contractor.

This information should be included as part or commencement of the Health and safety file for the project.

* NB: ALL PROPOSED SITE AND FLOOR LEVELS TO MATCH EXISTING LEVEL HEIGHTS. ALL LEVELS ABOVE GROUND LEVEL WILL MATCH EXISTING.

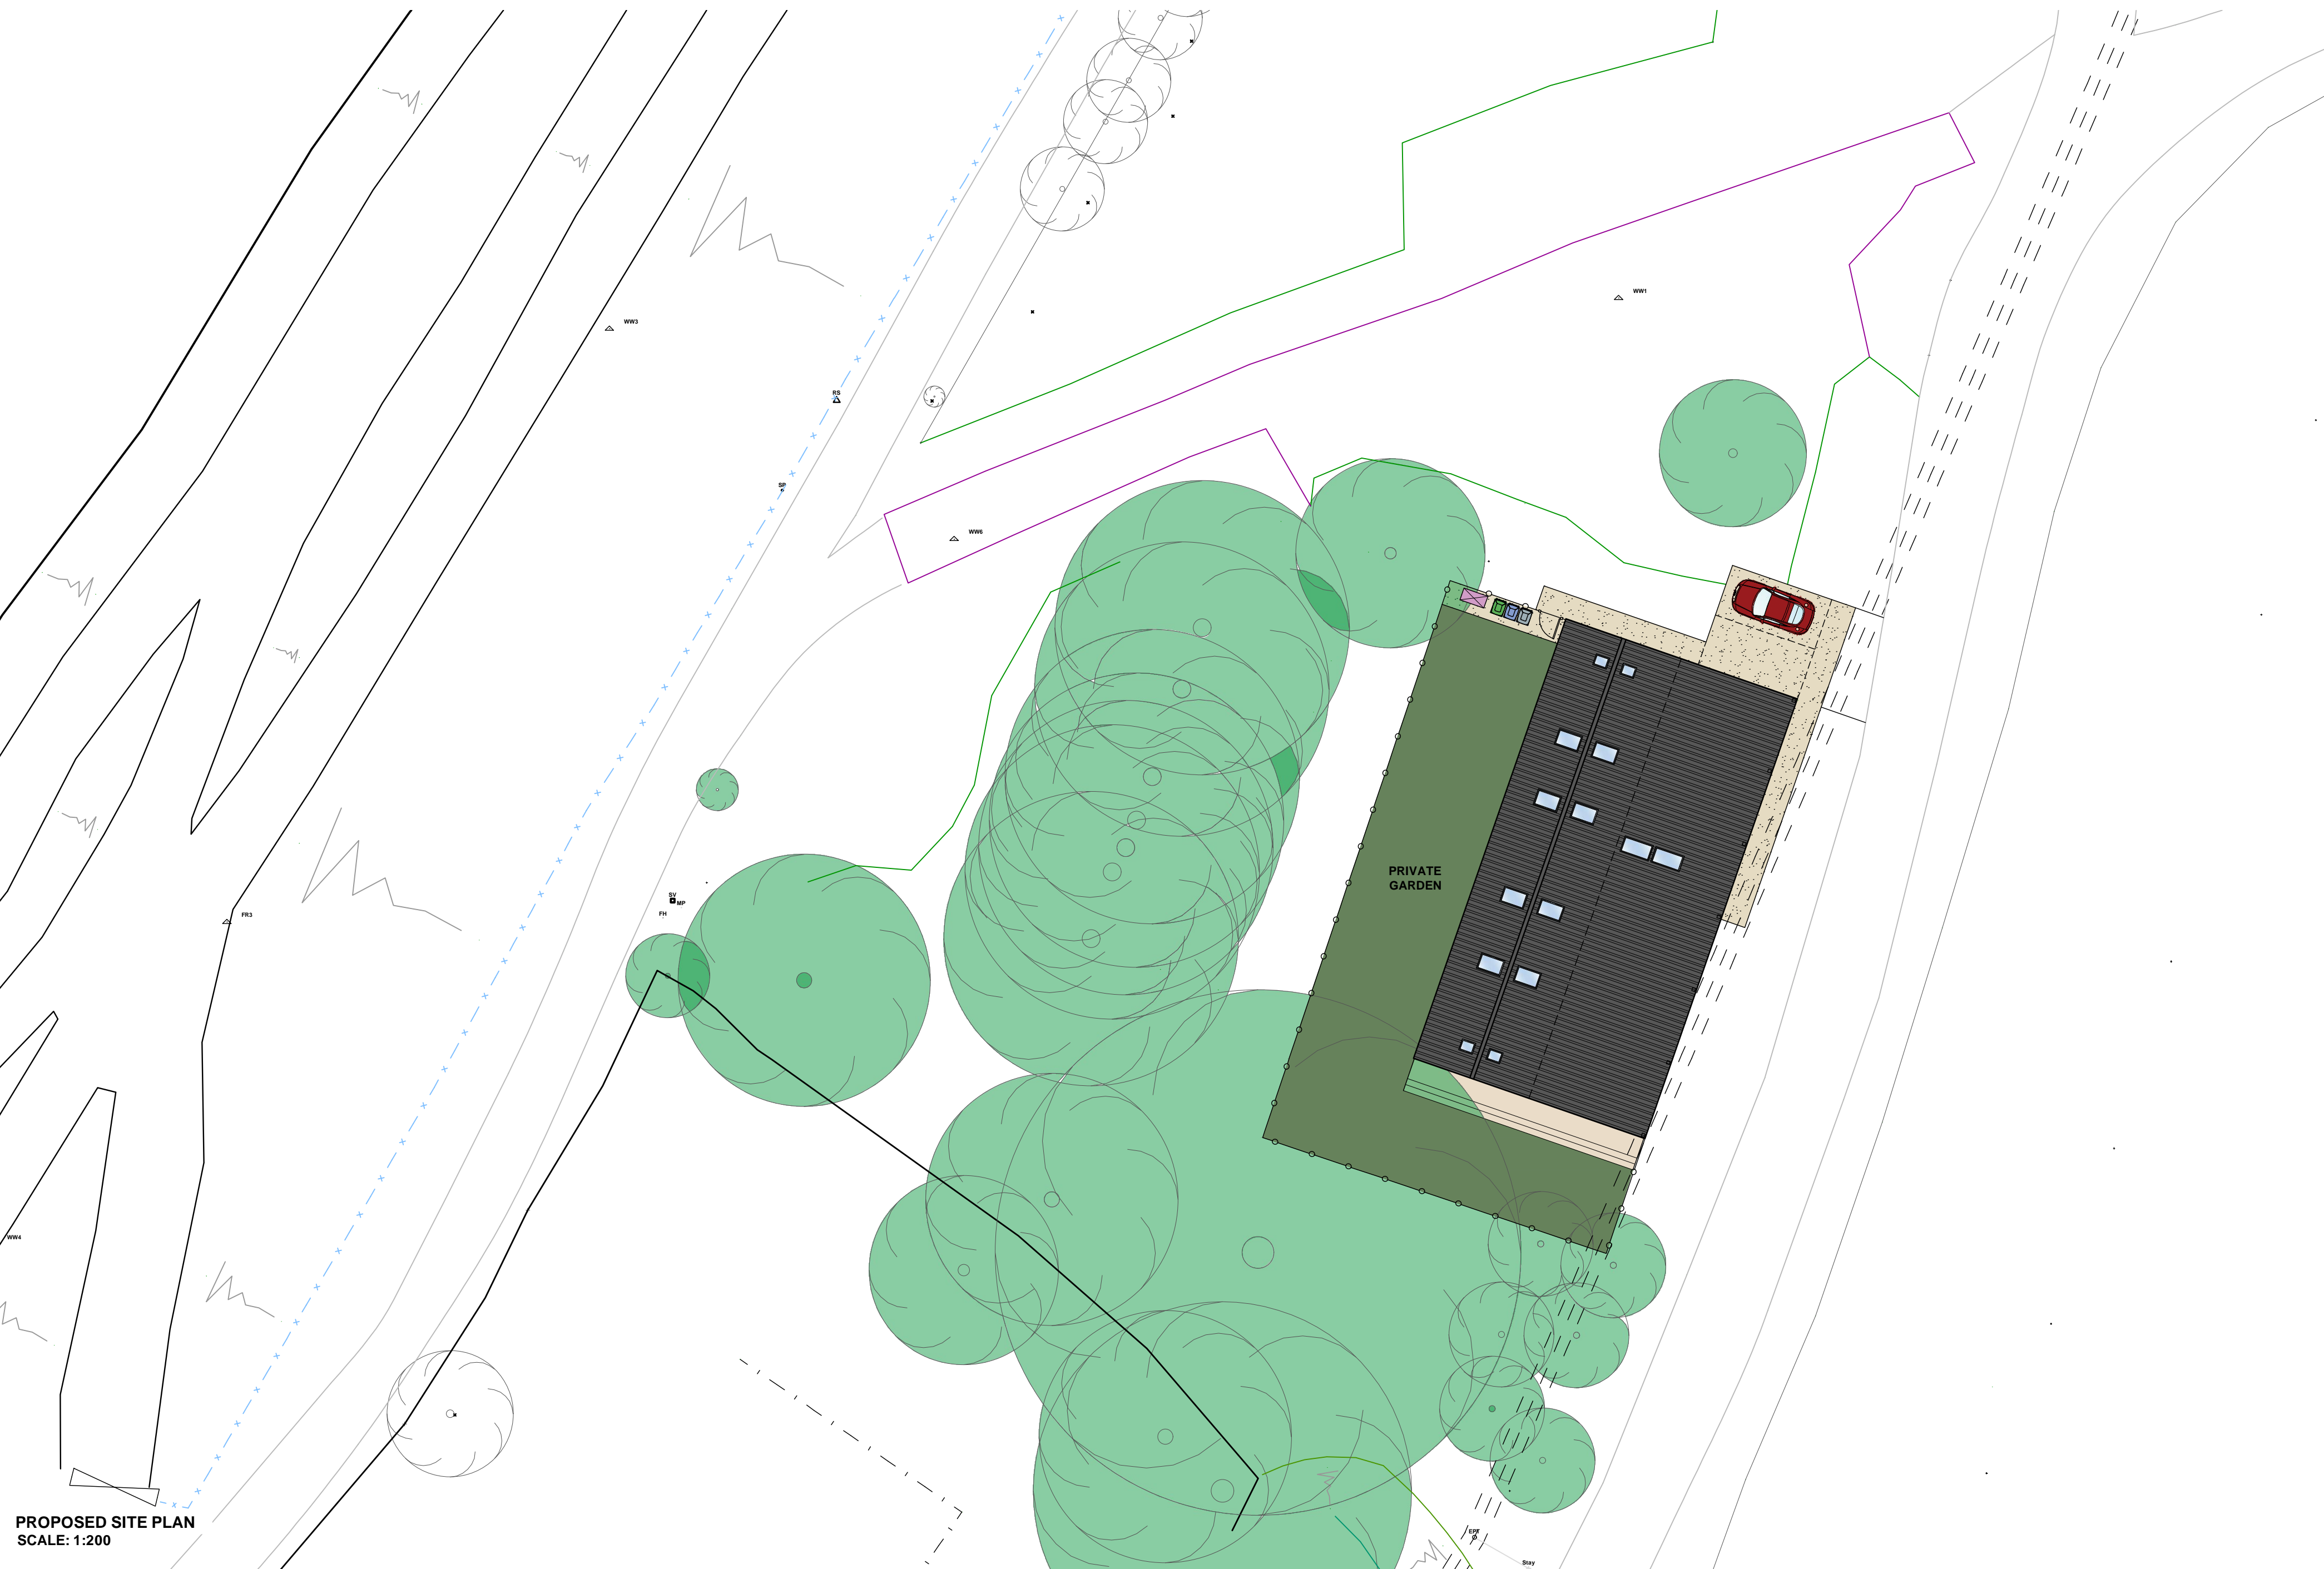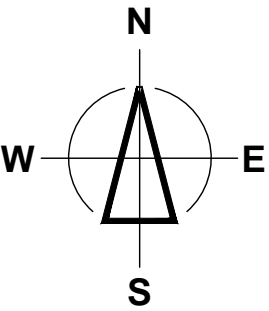

PROPOSED SITE PLAN
SCALE: 1:200

FINISHES LEGEND

EXTERNAL STEPS / LANDING

PRIVATE GARDEN AREA

PERMEABLE RESIN

1.2m HIGH CLOSE BOARDED FENCE

1.2m HIGH CLOSE BOARDED FENCE

EXISTING TREES

ASHP

BINS

E	08.11.2023	PROPOSED MATERIALS UPDATED TO SUIT EXISTING MATERIALS
D	08.11.2023	PROPOSED ELEVATIONS AND SECTION ADDED
C	08.11.2023	LAYOUT UPDATED TO SUIT PLANNERS COMMENTS
B	28/07/2023	LAYOUT UPDATED TO SUIT PLANNERS COMMENTS
A	20/01/2023	TITLE BOX UPDATED
no	date	amendment description

Revisions

Drawing Status: **PLANNING**

trundley
DESIGN SERVICES
www.trundley.com

Salgate Barn
Islington Road
Tilney All Saints
King's Lynn
Norfolk
PE34 4RY
Tel: 01553 617700
Fax: 01553 617874
Email: enquiries@trundley.com

Project Title:

E W KISBY & SON
C/O CRUSO & WILKIN
THE ESTATE OFFICE,
CHURCH FARM, STATION ROAD,
HILLINGTON, PE31 6DH

CLASS Q BARN CONVERSION

Drawing Title:

PROPOSED SITE PLAN, ELEVATIONS & SECTIONS

Scale:

AS STATED @ A1 DEC 2022

Date:

EL

Drawing Number:

22-P37-PL004E

Checked by:

Date:

If this drawing is unsigned in the check box then the drawing is an unauthorised issue and should not be used for any purposes